

SCALE @ 24" X 36"

______ CRAWL SPACE VENTS @ DAMP PROOF REQ'D ON PF METHOD MIN. (2) 1/2" DIAMETER ANCHOR BOLTS SPACED IN EQUAL 1/3 INCREMENTS. W/ 2" X 2" PLATE WASHERS _______ COVERED PORCH 4" CONCRETE SLAB OVER 4" COMPACTED GRAVEL BASE 2 X 4 PONY WALL OVER 8"X16" _ FOOTING 9 1/2" BCI'S @ 16" O.C. 30" CLEARANCE BELOW FLOOR JOISTS MIN. 24" MIN. & 36" MAX OVER DIG FROM 2 X 4 PONY WALL OVER 8"X16" FOOTING 22" X 30" CRAML ACCESS PANEL FIRE CAULK ALL
PENETRATIONS ON
COMMON WALLS FROM
MECH. 2 X 4 PONY WALL OVER 8"X16" FOOTING STEEL IMPACT__/ POST GARAGE 4" CONC. SLAB OVER 4"
COMPACTED GRAVEL
SLOPE 2" TO O.H. GARAGE
DOORS

PF METHOD MIN. (2) 1/2" DIAMETER ANCHOR BOLTS SPACED IN EQUAL 1/3 INCREMENTS. W/ 2" X 2" PLATE WASHERS

18'0" X 8'0" GARAGE O.H.D.

FOUNDATION PLAN

COVERED PORCH 4" CONCRETE SLAB OVER 4" COMPACTED GRAVEL BASE

SCALE: 1/4" = 1' - 0"

GLU LAM SIMPSON POST 4 X 4 POST MIN. SIMPSON POST BASE ISOLATE PIERS FROM CONCRETE SLAB ACCORDING TO FINISHED COLUMN SIZE INCLUDING ANY MASONRY CONC. PAD BELOW FROST LINE


TYP. POST & PIER DETAIL

NOT TO SCALE

EXTERIOR FINISH AS SPEC. - 1/2" GYP. BOARD TYP. FINISH _ R - 21 INSULATION 7/16" O.S.B. W/ MATERPROOF BUILDING PAPER 6" CONCRETE FOUNDATION WALL **MRAPPED AS** - (2) # 4 REBARS CONTINUOUS HOR. SHEAR MALL W/ VERTS. 48" O.C. MAX. 2 X 6 P.T. SILL PLATE - 1 X EXP. JOINTS @ PERIMETER W/ 1/2" X 10" A.B. @ < 4' - 0" O.Ō. 4" CONC. SLAB OVER 4" COMPACTED GRAVEL OVER UNDISTURBED EARTH GRADE 10.5 order 2 o TOP FTG. Р В*О*Т FTG. <u>Ш</u> 8" X 16" CONC.
FOOTING (2) #4
REBARS CON. HOR. W
VERTS. 48" O.C. MAX


TYP. GARAGE DETAIL

SCALE: 1/2" = 1' - 0"

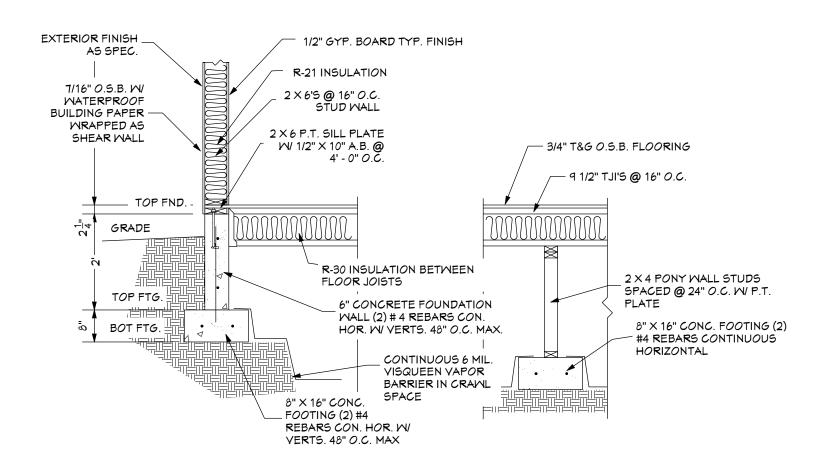

BUILDING SEC. DETAIL

SCALE: 1/2" = 1' - 0"

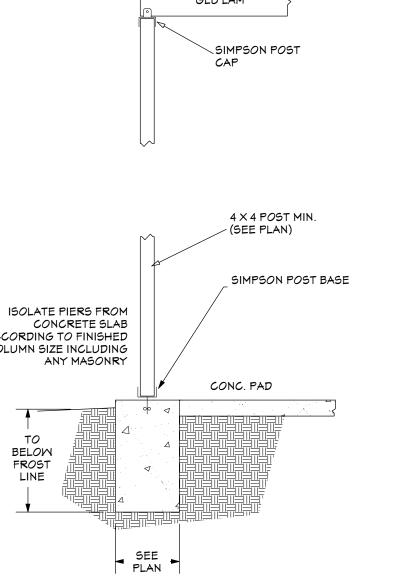

FOUNDATION NOTES:

VERIFY ALL WINDOW AND DOOR ROUGH OPENING SIZES BEFORE FORMING BLOCK OUTS AS

PROVIDE EXPANSION JOINTS AS NECESSARY IN ALL FLATWORK.

COORDINATE ALL SIDEWALK LOCATIONS WITH HOMEOWNER.

ALL FOUNDATION WALLS SHALL BE MIN. 3000 # / SQ. IN. COMPRESSIVE STRENGTH @ 28 DAYS. ANY PORCHES, PARKING SLABS, STEPS AND GARAGE FLOOR SHALL BE MIN. 3500 # / SQ. IN. COMPRESSIVE STRENGTH @ 28 DAYS.

1/2" X 10 " ANCHOR BOLTS @ 4' O.C. MAX. EACH SECTION OF SILL PLATE MUST HAVE MIN. (2) ANCHOR BOLTS MAX. DISTANCE FROM END OF ANY SILL PLATE SECTION TO ANCHOR BOLT SHALL

PONY WALLS TO BE 2 X 4's @ 24" O.C. W/ PRESSURE TREATED SILL PLATE AND DOUBLE TOP

ROOF / SECOND FLOOR BEARING AND PONY WALLS TO BE SOLID BLOCKED IF RUNNING PERPINDICULAR TO JOISTS AND FRAMED TO SUBFLOOR WHEN RUNNING PARALLEL TO JOIST. INSTALL TJI'S PER MANUFACTURERS RECOMMENDATIONS INCLUDING ALL BRIDGING AND

ANY NAILS THAT PENETRATE CONCRETE OR PRESSURE TREATED LUMBER TO BE HOT DIPPED GALVANIZED OR EQUAL.

EXCAVATE TO MIN. 30" BELOW JOISTS. INSTALL 6 MIL. VISQUEEN VAPOR BARRIER IN CRAWL

SEE BRACING WALL PANEL FOR HOLD DOWN LOCATIONS AND DESCRIPTIONS.

VENTING RATIO TO BE 1 SQ. FT. VENT / 1500 SQ. FEET OF CRAWL SPACE.

ALL OPENINGS IN THE EXT. BLDG. ENVELOPE SHALL BE SEALED AGAINST AIR INFILTRATION. THE FOLLOWING AREAS MUST BE SEALED.

* JOINTS AROUND WINDOW AND DOOR FRAMES * JOINTS BETWEEN WALL CAVITY AND WINDOW * JOINTS BETWEEN WALL AND FOUNDATION

* JOINTS BETWEEN WALL AND ROOF * UTILITY PENETRATIONS THROUGH EXTERIOR WALLS

GRADE SLOPE: 6" DROP WITHIN FIRST 10' FROM FOUNDATION.



DATE: DEC. 2022

DRAWN BY: C.J.

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THE UPC REQUIRES A CRAWL SPACE ACCESS WITHIN 20 FEET OF ALL UNDER FLOOR CLEANOUTS.

ALL WINDOW AND EXTERIOR DOOR HEADERS ARE (2) 2 X 10's OR EQUIVALENT UNLESS

WINDOWS MARKED AS EGRESS SHALL MEET THE 2018 IRC. MIN. REQUIREMENT.

DESIGNER ASSUMES NO RESPONSIBILITY FOR STRUCTURAL INTEGRITY. VERIFY ALL STRUCTURAL SPECIFICATIONS W/ MANUFACTURER, TRUSS VENDOR OR ENGINEER.

BATH AND RANGE HOOD FANS INDICATED SHALL VENT TO OUTSIDE AND MEET ALL

REQUIREMENTS OF THE 2018 IRC. AND BE SMOOTH PIPING WITH MIN. 50 CFM.

KITCHEN AND BATHROOM DESIGNS AND LAYOUT AS PER. OWNER.

VENT DRYER EXHAUST TO DUCT IN WALL AND VENT OUTSIDE.

WINDOWS SET @ 80" UNLESS OTHERWISE NOTED.

COORDINATE ALL INTERIOR AND EXTERIOR FINISH, MATERIALS AND COLORS WITH HOME

ALL CRAWL SPACE AND ATTIC OPENINGS TO BE 22" X 30" UNLESS OTHERWISE NOTED.

5/8" TYP. "X" SHEETROCK ON CEILINGS AND WALLS BETWEEN GARAGE AND LIVING SPACES INCLUDING BONUS ROOMS.

GARAGE DOOR HEADERS TO BE INSTALLED PER WALL BRACING SCHEDULE. (VERIFY SIZING W/ TRUSS VENDOR OR ENGINEER ON OPENINGS WITH ADDITIONAL LOAD ABOVE HEADERS SUCH AS DORMERS AND SECOND FLOORS ETC.)

ENTRY DOORS FROM GARAGE TO HOUSE TO BE 20 MIN. LABELED SELF CLOSING HINGES.

FIRE CAULK ALL PENETRATIONS ON COMMON WALLS FROM MECHANICAL.

ELECTRICAL RECEPTACLES IN BATHROOMS, KITCHENS AND GARAGES SHALL BE G.F.I. OR

G.F.I.C. PER NATIONAL ELECTRICAL CODE REQUIREMENTS.

INSULATE ALL ACCESS DOORS/ HATCHES TO CRAWL SPACES AND ATTICS TO THE EQUIVALENT RATING OF THE WALL, FLOOR OR CEILING THROUGH WHICH THEY PENETRATE. UNO ON PLANS.

ATTIC R-38
WALLS R-20
FLOORS R-30

MISCELLANEOUS NOTES:

OWNER.

PROVIDE IMPACT PROTECTION PER IRC. CODE IF MECHANICAL IS IN LINE OF VEHICLE PARKING IN GARAGE.

SD SMOKE DETECTOR

SD CARBON MONOXIDE / SMOKE DETECTOR

FAN UNIT


T TEMPERED GLASS

E EGRESS WINDOW

SINGLE FAMILY RESIDENCE:

MAIN FLOOR 1801 SF FRONT PORCH 190 SF REAR PORCH 298 SF GARAGE 645 SF TOTAL 2934 SF



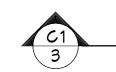

CROSS SECTION

FOR ILLUSTRATION ONLY N.T.S.

MAIN FLOOR

6X6 POST FURRED _/ OUT TO 16" TYP.

. – – – – – – – – – + – – – – – .

COVERED PORGH

6068 GLASS SLIDER

9' 1 1/8" CEILING FROM F.F.

GREAT ROOM

9' 1 1/8" CEILING 10' 1 1/8" BOX HT'

LAUNDRY

DINING

9' 1 1/8" CEILING

KITCHEN

PANTRY 9' 1 1/8" CEILING

SHELVING

20 MIN. LABELED SELF CLOSING HINGE DOOR

> GARAGE 9' 1 1/8" CEILING FROM F.F.

5/8" TYP. "X" SHEETROCK ON CEILING AND COMMON WALLS IN GARAGE

-(2) 1 3/4" X 11 7/8" CONT. LVL HEADERS -

AC

6X6 POST 5

MASTER BEDROOM 9' 1 1/8" CEILING

9' 1 1/8" CEILING /

TILE & GLASS

CLOSET ROD & SHELVING

M.I.C. 9' 1 1/8" CEILING

┼ 4'-5" - - - - 3'-8 - ' '

9' 1 1/8" CEILING

ENTRY 9' 1 1/8" CEILING T SHELVING

CLOSET ROD & SHELVING

5'-8¹/₂" —

BEDROOM 3 9' 1 1/8" CEILING

TE


COVERED PORCH 9' 1 1/8" CEILING FROM F.F.

BEDROOM 2 9' 1 1/8" CEILING

CLOSET ROD & SHELVING



Figure R602.10.6.4 – CONTINUOUSLY SHEATHED PORTAL FRAME

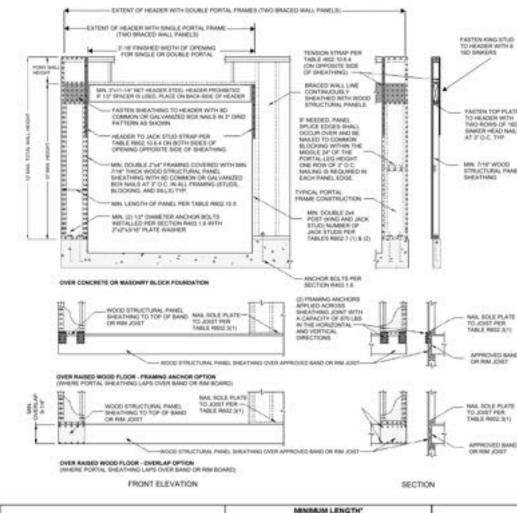

METHOD (See Table R602,18.4)		MINIBUM LENGTH' (Inches) Wall Height					CONTRIBUTING LENGTH	
DWB, WSP, SFB, PBS, PCP, HPS, BV-WSP		48	48	48	53	58	Actual	
GB LIB		48	48	48	53	58	Double sided = Acts Single sided = 0.5 × Ac	
		55	62	69	NP	NP.	Actual ^b	
ABW	SDC A, B and C, ultimate design wind speed < 140 mph	28	32	34	38	42	48	
	SEC D ₅ , D ₁ and D ₂ , ultimate design wind speed < 140 mph	32	32	34	NP	NP		
CS-G		24	27	30	33	36	Actual ^b	
	Adjacent clear opening height (inches)							
	≤ 64	24	27	30	33	36		
	68	26	27	30	33	36	1	
	72	27	27	30	33	36	1	
	76	30	29	30	33	36	1	
	80	32	30	30	33	36	1	
	84	35	32	32	33	36		
	88	38	35	33	33	36		
	92	43	37	35	35	36		
	96	48	- 41	38	36	36	1	
CS-WSP, CS-SFB	100	-	44	40	38	38	Actual ^b	
	104	-	49	43	40	39		
	108	-	54	46	43	41		
	112	_	-	50	45	43		
	116		-	55	48	45		
	120	-	-	60	52	48		
	124	-	-	-	56	51		
	128	-			61	54		
	132	-	-	-	- 66	58		
	136	-	-	-	-	62		
	140	_	-	-	-	00		
	144	-	-	-	-	72		
METHOD		Portal header height						
(See Table R602.10.4)		8 feet	9 feet	10 Feet	11 feet	12 feet		
PFH	Supporting roof only	24	24	24	Note c	Note c	48	
	Supporting one story and roof	24	24	24	Note e	Note c		
- V	PPG	24	27	30	Note d	Note d	1.5 × Actual	
CS-PF	SDC A, B and C	16	18	20	Note e	Note e	1.5 × Actual	
	SDC D ₁ , D ₂ and D ₂	24	24	24	Note e	Note e	Actual ^b	

NP = Not Permitted.

Linear interpolation shall be permitted.
Use the actual length where it is greater than or equal to the minimum length.
Maximum header height for PFH is 10 feet in accordance with Figure R602.10.6.2, but wall height shall be permitted to be increased to 12 feet with pony wall.
Maximum header height for PFG is 10 feet in accordance with Figure R602.10.6.3, but wall height shall be permitted to be increased to 12 feet with pony wall.
Maximum header height for CS-PF is 10 feet in accordance with Figure R602.10.6.4, but wall height shall be permitted to be increased to 12 feet with pony wall.

METHODS, MATERIAL			1000000	CONNECTION CRITERIA*			
		MINIMUM THICKNESS	PIGURE	Fasteners	Spacing		
g Methods	PFH Portal frame with hold-downs	3/4"		See Section R602.10.6.2	See Section R602.10.6.		
Intermittent Beacing	PFG Portal frame at garage	7/16*		See Section R602.10.6.3	See Section R602.10.6.		
Centinaous Sheathing Methods	CS-WSP	3/8"		Exterior sheathing per Table R602.3(3)	6" edges 12" field		
	Continuously sheathed wood structural punel			Interior sheathing per Table R602.3(1) or R602.3(2)	Varies by fasteser		
	CS-G ^{h, e} Continuously sheathed wood structural panel adjacent to garage openings	3/6-		See Method CS-WSP	See Method CS-WSP		
	CS-PF Continuously sheathed portal frame	7/26.*		See Section R602.10.6.4	See Section R602.10.6.		
	CS-SFR ⁴ Continuously sheathed structural fiberboard	¹ / ₂ " or ²⁵ / ₃₂ " for maximum 16" stud specing		1 ½ long × 0.12 dia. (for ½ thick sheathing) 1½ long × 0.12 dia. (for ½½ thick sheathing) galvanized roofing nails or 8d common (2½ tolong × 0.131 dia.) nails	3" edges 6" field		

Adherive attachment of wall sheathing, including Method GB, shall not be permitted in Seismic Design Categories C, D₁ and D₂.
 Applies to parter to garage door opening where supporting gable each wall or roof load only. Shall only be used on one wall of the garage. In Seismic Design Categories D₁ and D₂ roof covering dead load shall not exceed 3 psf.
 Garage openings adjacent to a Method CS-G panel shall be provided with a header in accordance with Table 8002.7(1). A full-height clear opening shall not be permitted adjacent to a Method CS-G panel.

	BRA	CING REQUIREME	NTS BASED O	N WIND SPE	ID			
EXPOSURE CATEGORY B 30-FOOT MEAN ROOF HEIGHT 10-FOOT WALL HEIGHT 2 BRACED WALL LINES			MINIMUM TOTAL LENGTH (FEET) OF BRACED WALL PANELS REQUIRED ALONG EACH BRACED WALL LINE*					
Ultimate Design Wind Speed (mph)	Story Location	Braced Wall Line Spacing ^c (feet)	Method LiB ^b	Method GB	Methods DWB, WSP, SFB, PBS, PCP, HPS, BV-WSP, ABW, PFH, PFC, CS-SFB	Methods CS-WSP, C G. CS-PF		
		10	3.5	3.5	2.0	2.0		
		20	6.5	6.5	3.5	3.5		
		30	9.5	9.5	5.5	4.5		
		40	12.5	12.5	7.0	6.0		
		50	15.0	15.0	9.0	7.5		
		60	18.0	18.0	10.5	9.0		
		10	7.0	7.0	4,0	3.5		
	_	20	12.5	12.5	7.5	6.5		
10.000		30	18.0	18.0	10.5	9.0		
≤ 115		40	23.5	23.5	13.5	11.5		
		50	29.0	29.0	16.5	14.0		
		60	34.5	34.5	20.0	17.0		

BRACING PLAN

CS-WSP

CS-WSP

PROVIDE 2X4 PANEL EDGE BLOCKING @ ALL DESIGNATED BRACED WALL PANEL LOCATIONS (ALL "RIP" SHEETS MUST BE 12" MIN.)

CS-PF

CS-WSP

| | = = = ==

CS-WSP

CS-WSP


3.5' REQ'D 4.0' PROV

SCALE @ 24" X 36"

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22-169NI LOT 25B.PL



(Truss aligned with stud)

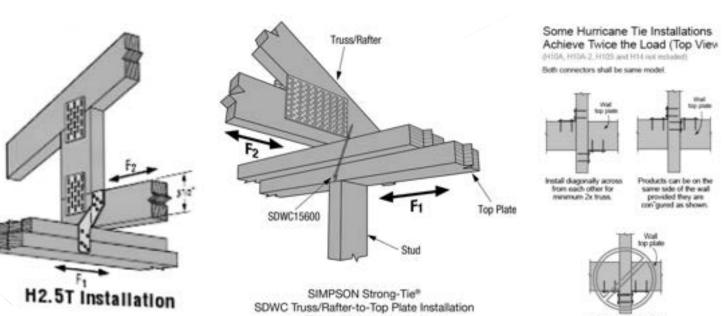Nailing into both sides of a single pty 2x truss may cause the wood to split.



ROOF FRAMING / TRUSS NOTES:

TRUSS DRAWING IS FOR ILLUSTRATION ONLY. ALL TRUSSES TO BE DESIGNED BY ENGINEER OR TRUSS VENDOR. INSTALL TRUSSES PER MANUFACTURERS RECOMMENDATIONS INCLUDING ALL BRIDGING & BRACING TO DRAWINGS & SPECIFICATIONS.

ALL TRUSSES SHALL CARRY MANUFACTURERS STAMP.

ALL TRUSSES WILL NOT BE FIELD ALTERED WITHOUT PRIOR BUILDING DEPT. OR TRUSS VENDOR APPROVAL.

ALL TRUSSES SHALL HAVE DESIGN DETAILS & DRAWINGS ON SITE FOR FRAMING INSPECTION. ALL CONNECTIONS OF RAFTERS, JACK OR HIP TRUSSES TO MAIN GIRDER TO BE PROVIDED BY TRUSS MANUFACTURER.

ALL ROOF FRAMING 24" O.C. UNLESS OTHERWISE NOTED.


RAFTERS FOR OVERBUILDS PER IRC TABLE 802.4.1(3). RIDGEBOARDS & SLEEPERS TO BE MIN 2" TALLER THAN RAFTERS.

ALL OVERHANGS 16" UNLESS OTHERWISE NOTED.

VERIFY ALL BEAM SIZING WITH TRUSS MANUFACTURER OR ENGINEER TO SUPPORT ROOF STRUCTURE. PROVIDE MEANS TO RESIST UPLIFT AT EACH LOCATION SHOWN ON TRUSS DESIGN DETAIL.


USE HURRICANE TIES AS REQ'D AND H-CLIPS BETWEEN ALL ROOF SHEETING. PROVIDE COLLAR TIES FOR HAND FRAMED ROOF RAFTERS.


COORDINATE EXACT LOCATION OF ATTIC ACCESS WITH MIN. 30" HEAD ROOM ABOVE HATCH PER 2018 IRC. ATTIC VENTILATION: REQUIRED ABOVE HOUSE.

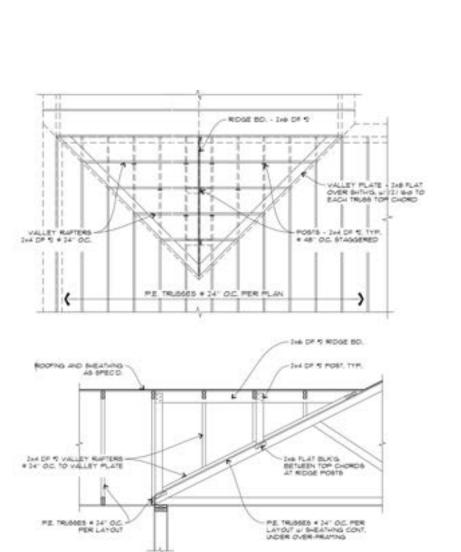

NOT TO SCALE


OVER FRAMING DETAIL

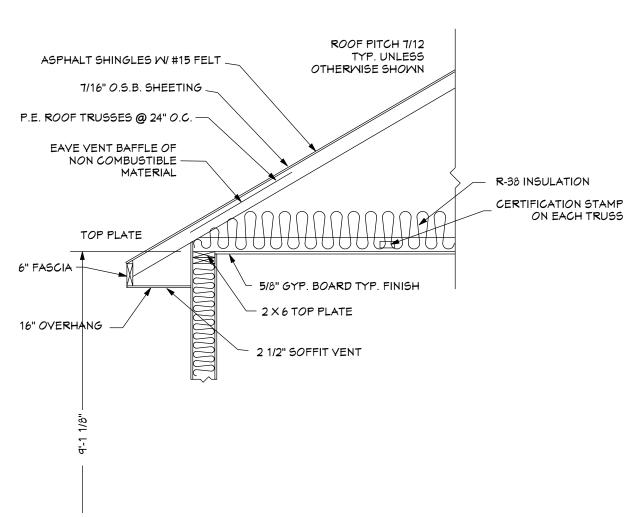

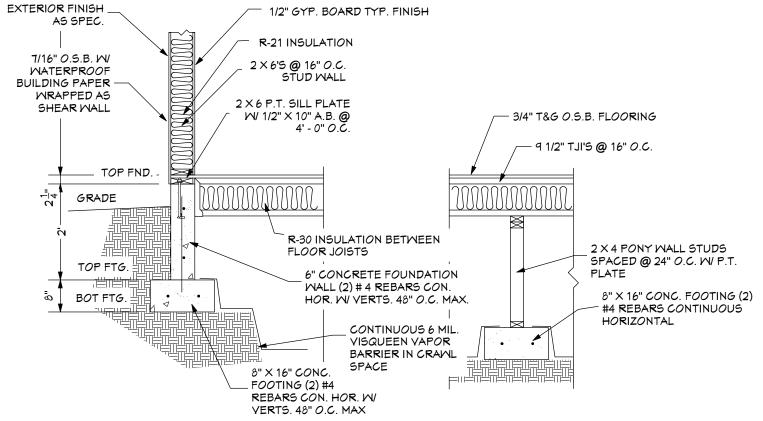



SCALE: 1/2" = 1' - 0"

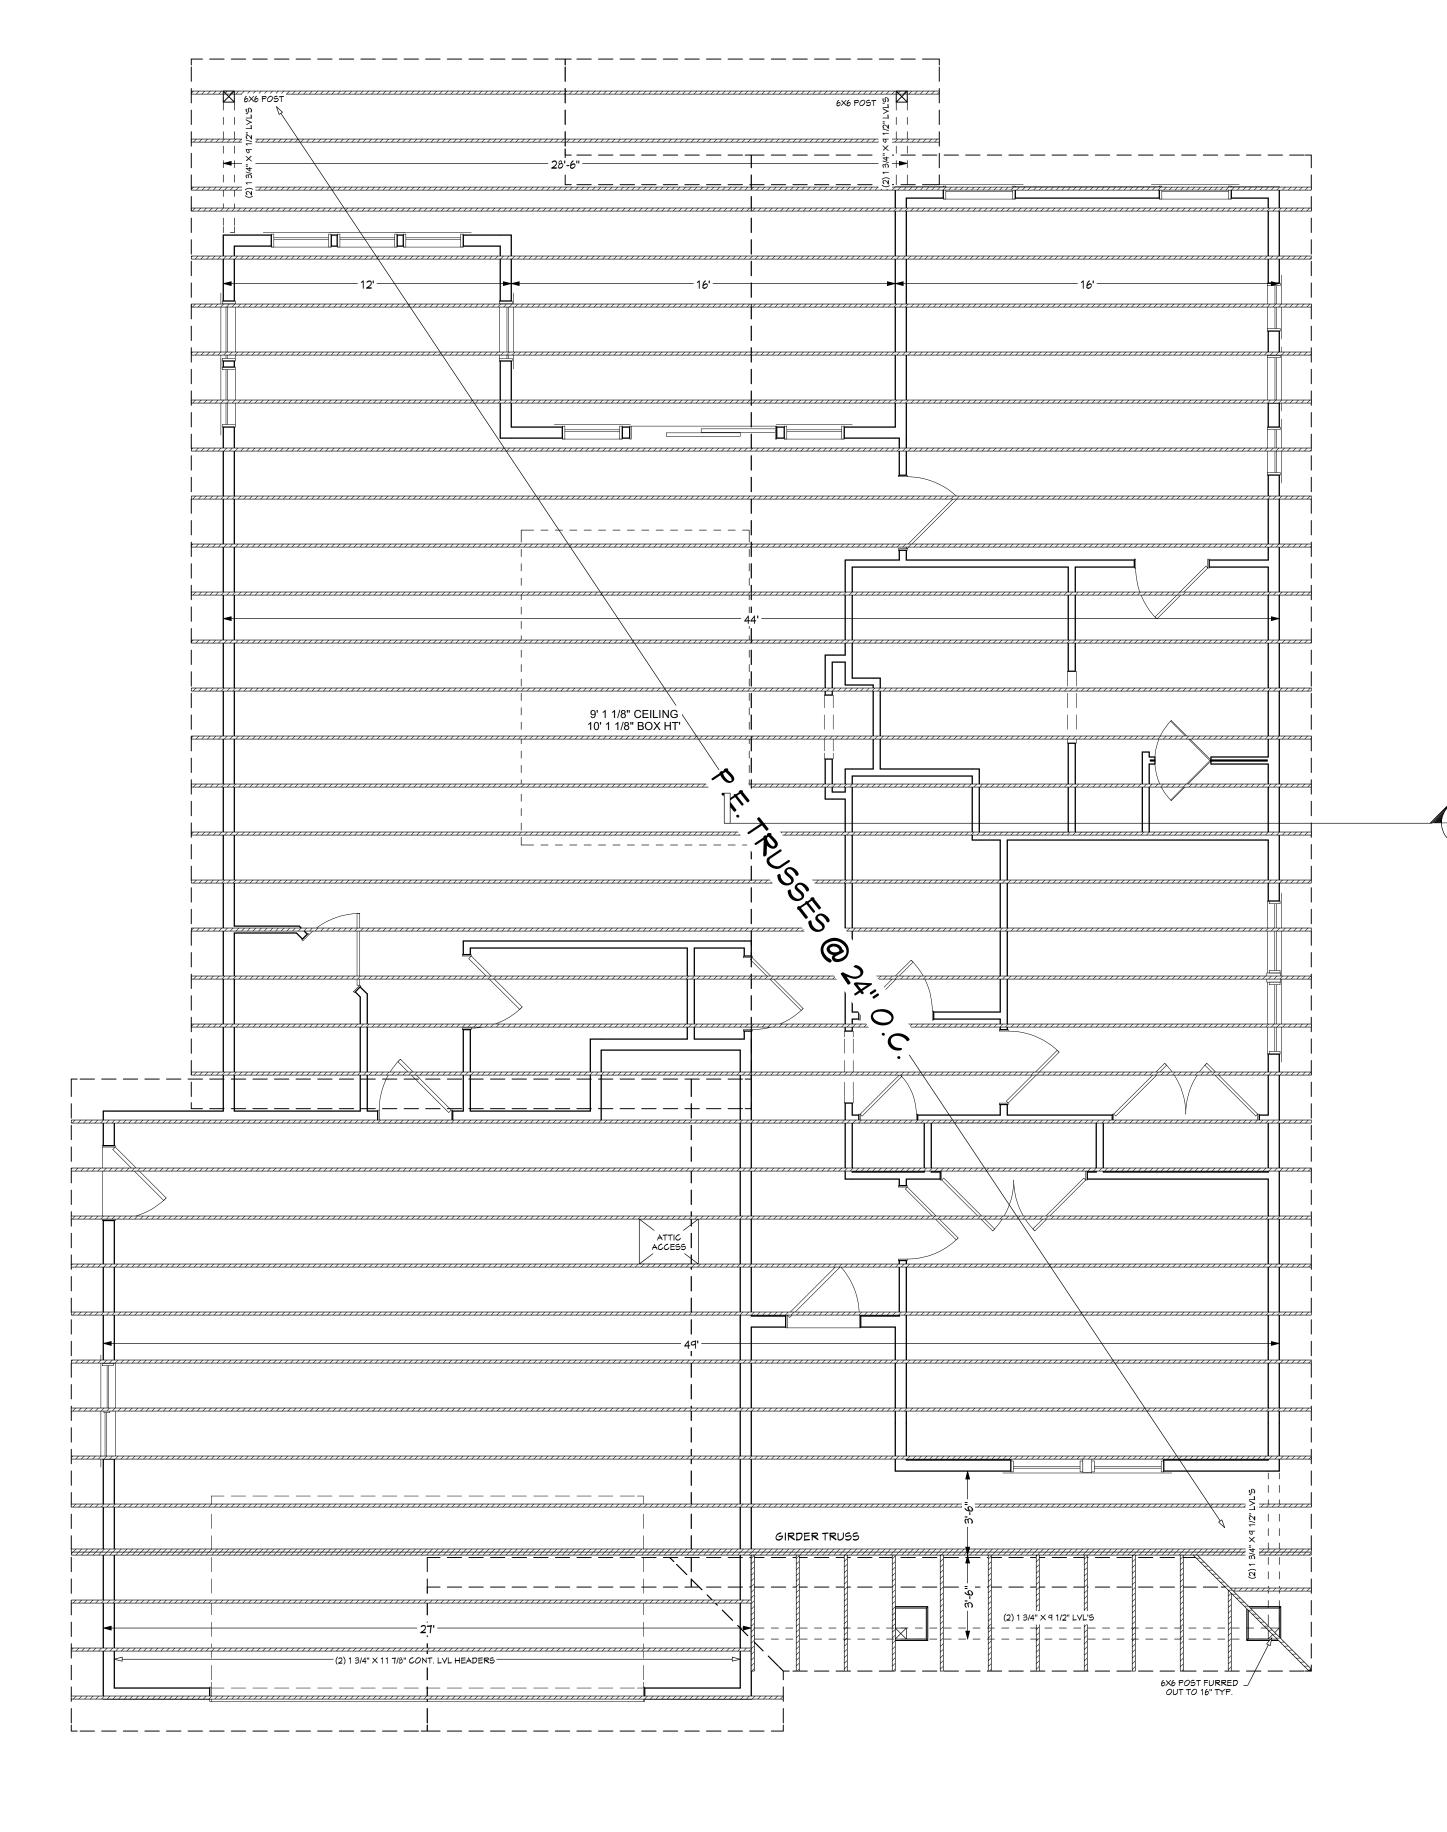

ROOF FRAMING PLAN

SCALE @ 24" X 36"

DATE: DEC. 2022

DRAWN BY: C.J.

22-169NI LOT 25B.PL

